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CONSTRUCTION DRAWINGS MR. & MRS. JOHN DOE



PO Box 35 Birnie MB RoJ oJo

PHONE: 204-966-3331 FAX: 204-841-3259 verlin@westmandrafting.com BOX 100 ANYTOWN MANITOBA R1R 1R1

PHONE:123-456-7890 MOBILE:234-567-8910

jdoe@gmail.com


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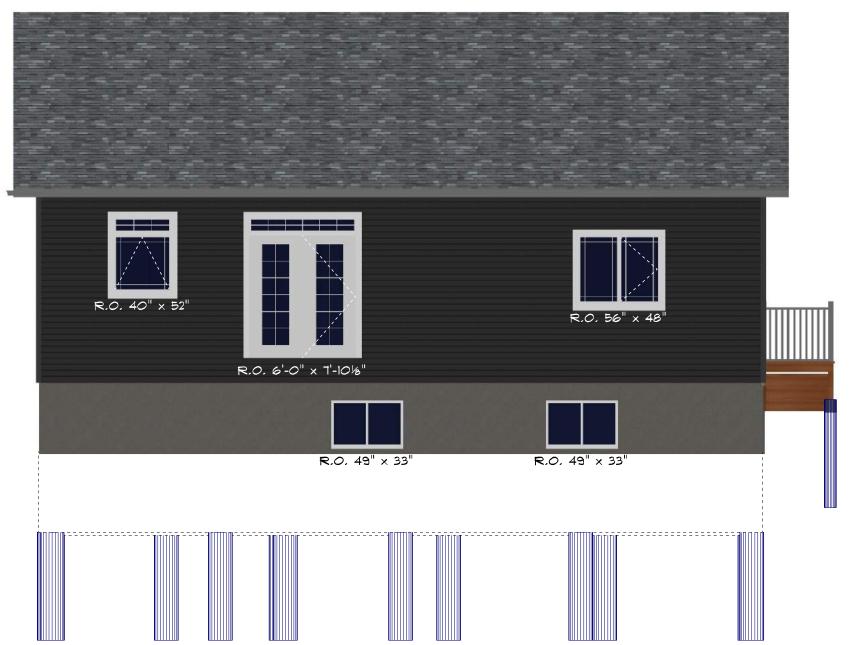
1496 SQ. FT. BUNGALOW ON ICF BASEMENT


PROJECT NUMBER: 15006

DRAWN BY: YERLIM

DATE: Friday, November 25, 2016



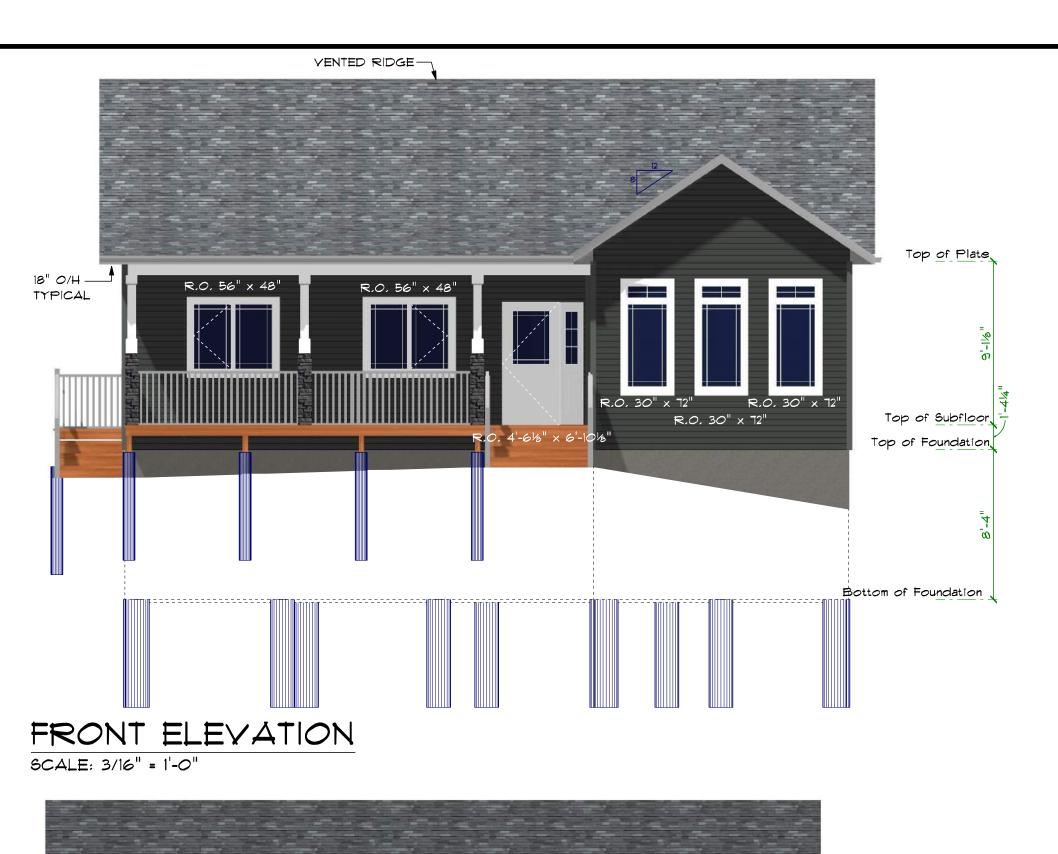

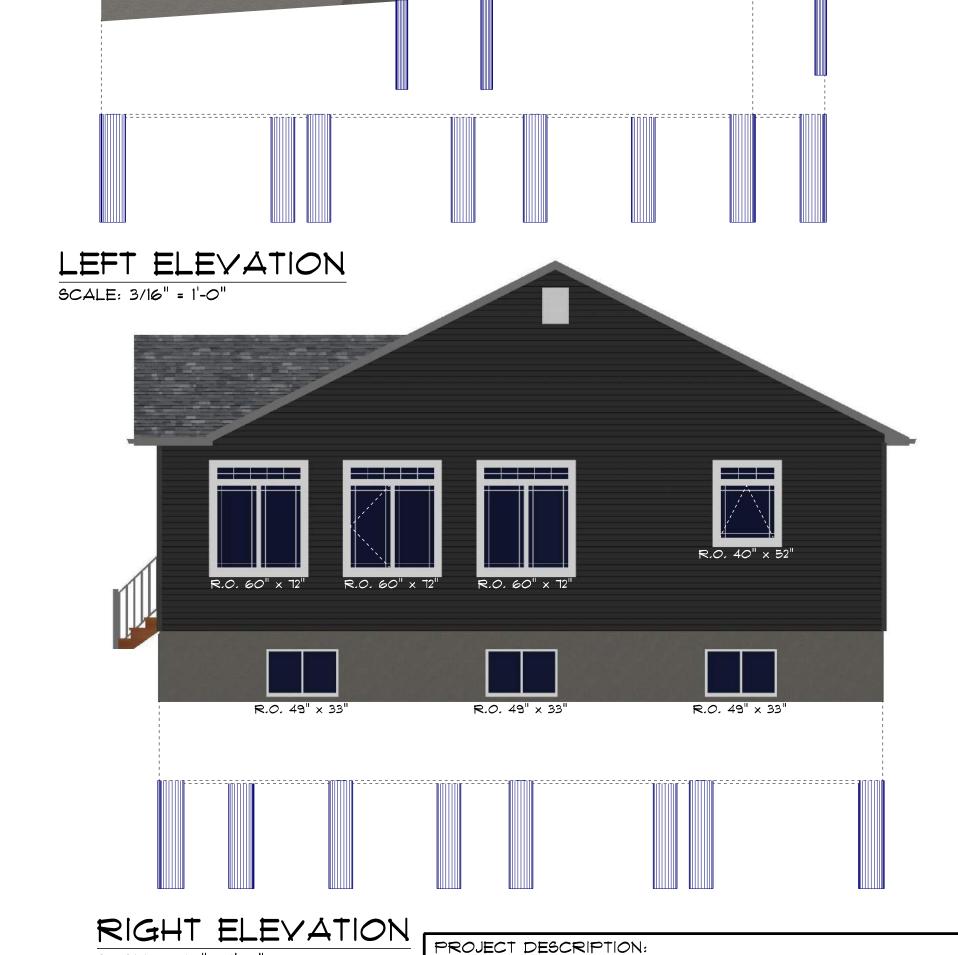


REAR ELEVATION

SCALE: 3/16" = 1'-0"

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SECTION 35 SECTION DETAIL NUMBER PAGE

PROJECT FOR: MR, & MRS, JOHN DOE LETTER BOX 100 ANYTOWN MANITOBA RIR IRI

DRAWN BY: VERLIN SCALE: 3/16" = 1'-0"

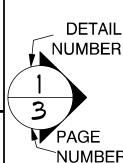SCALE: 3/16" = 1'-0"

12" O/A HEEL -

MOBILE: 234-567-8910

1496 SQ. FT. BUNGALOW ON ICF BASEMENT

PHONE: 123-456-7890 jdoe@gmail.com

YERIFY ALL DIMENSIONS, DATUMS, & ELEVATIONS PRIOR TO COMMENCEMENT

OF WORK,

DO NOT SCALE DRAWINGS


PROJECT NUMBER: 15006


DRAWING TITLE:

NUMBER NUMBER DATE: Friday, November 25, 2016

PAGE #:

ELEVATIONS

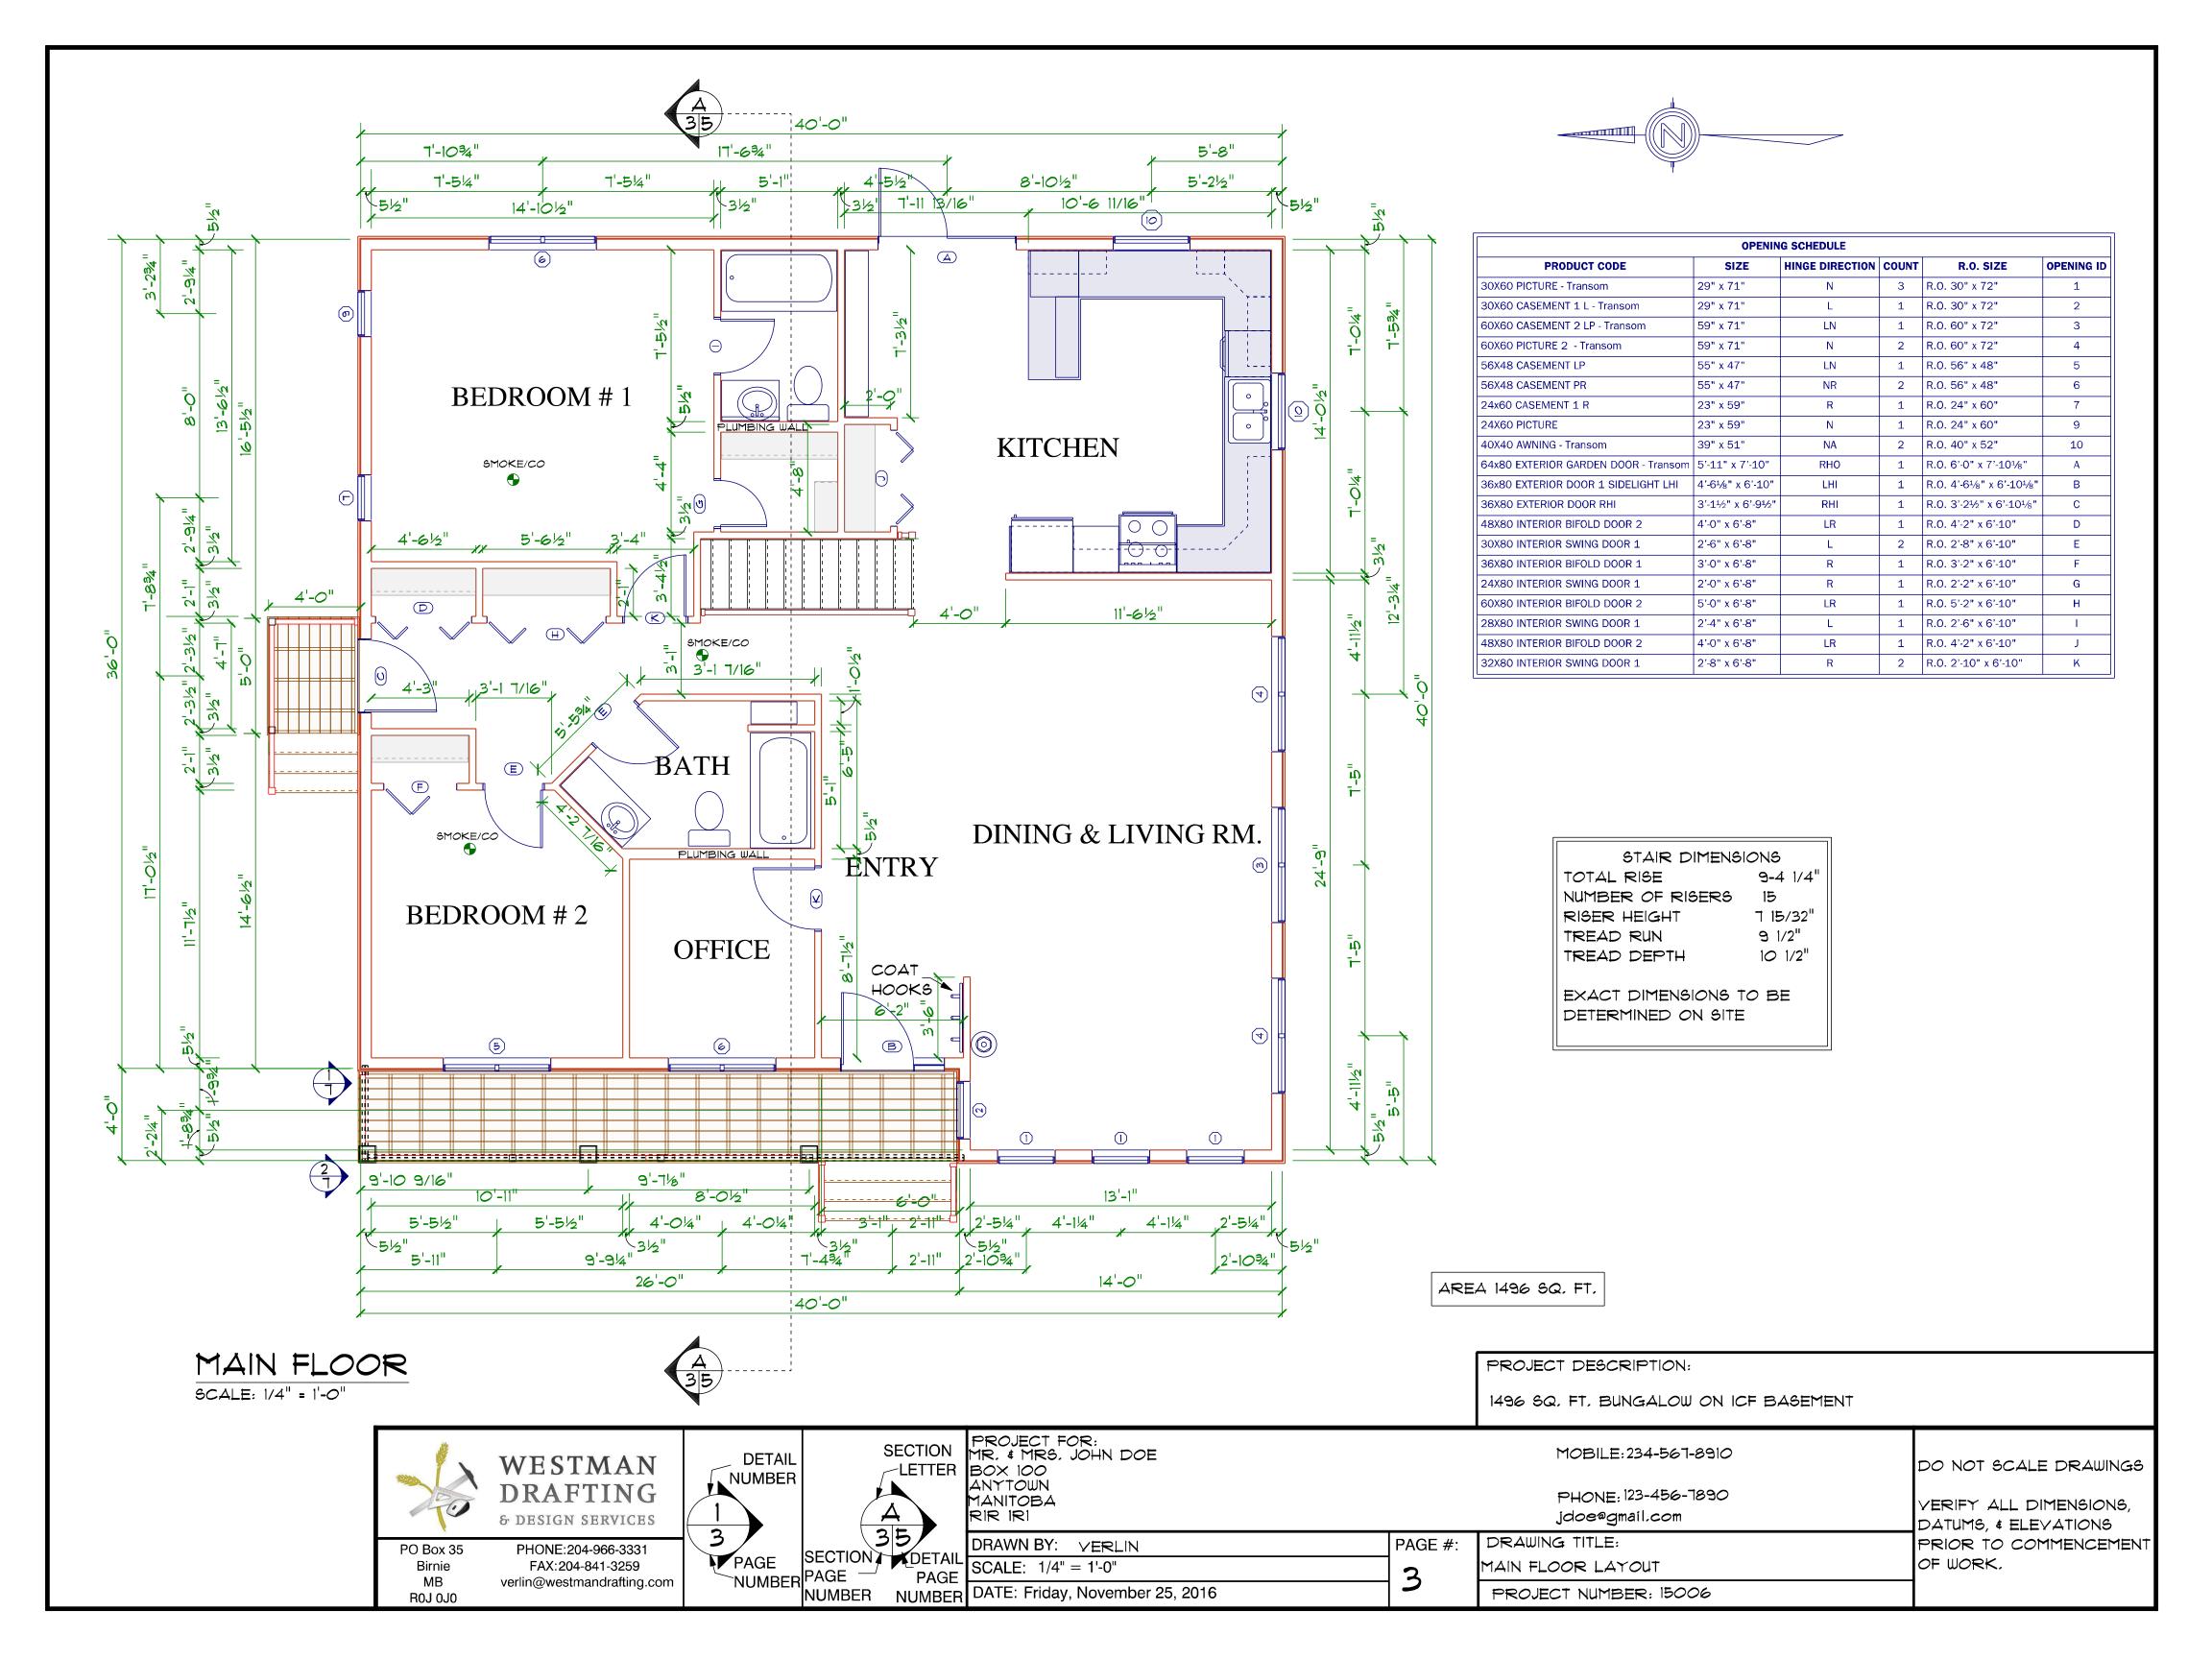

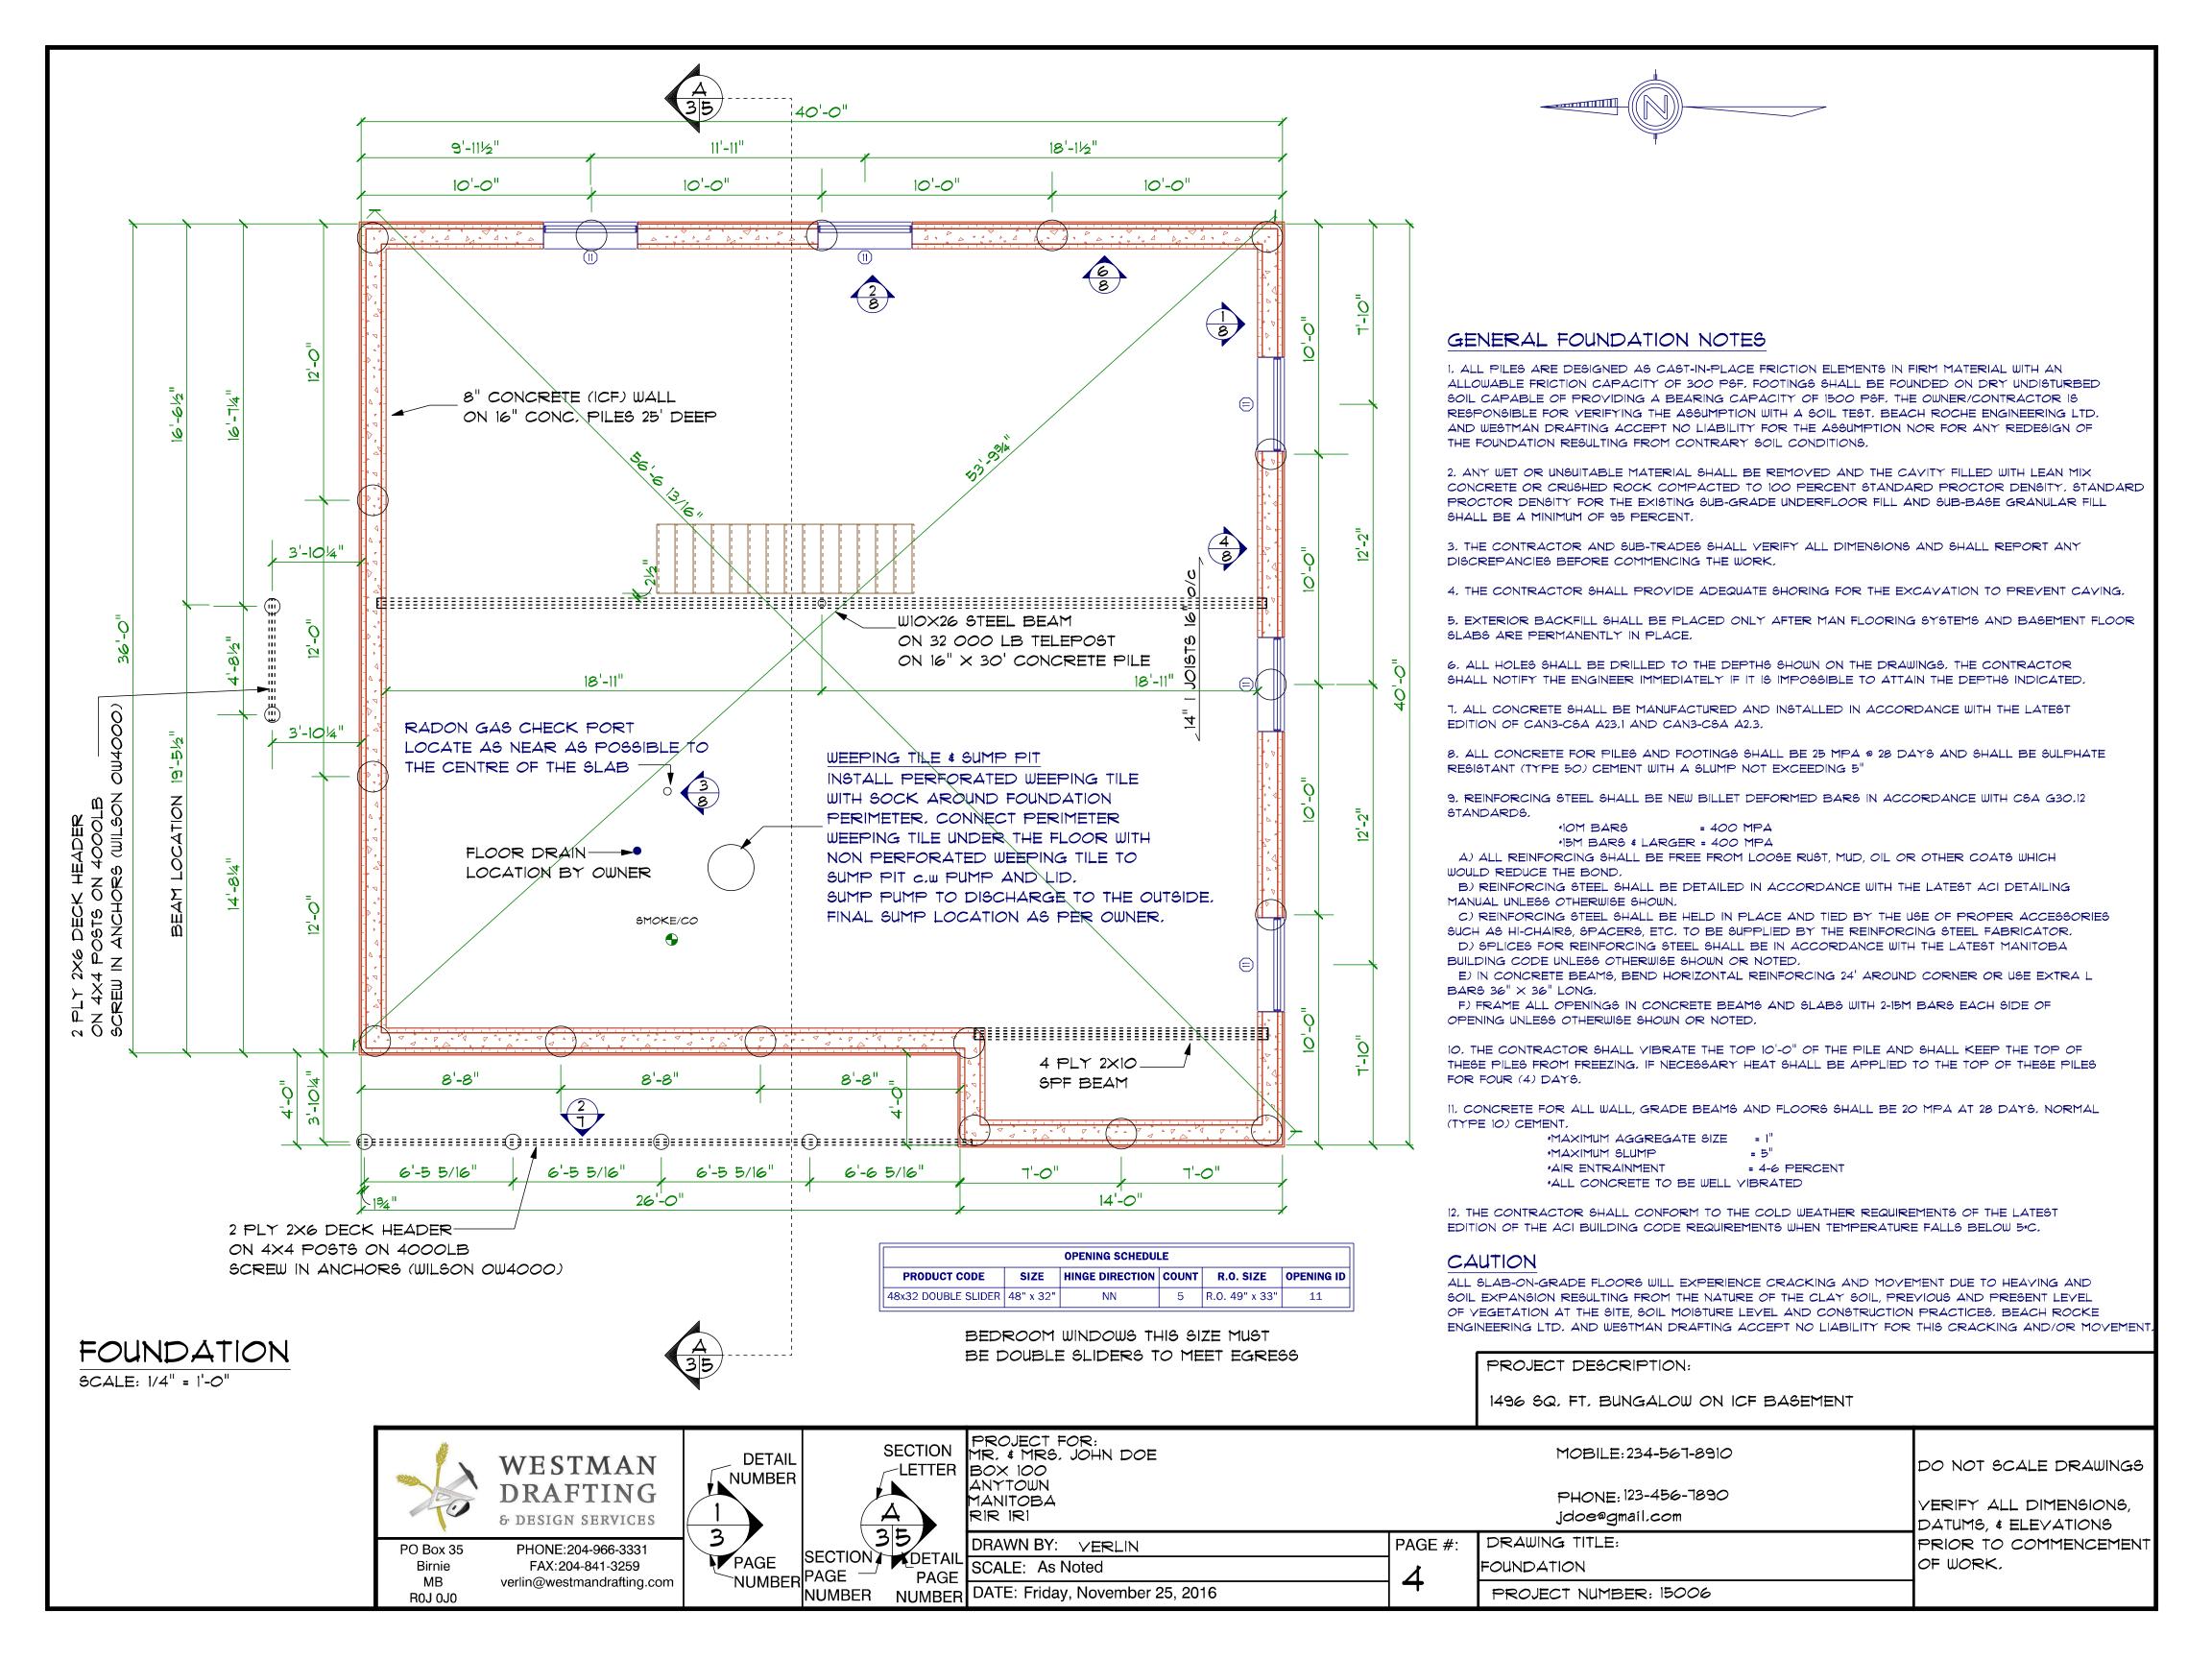

TYPICAL ROOF & EAVE DETAIL

30 YR FIBERGLASS SHINGLES ICE & WATER EAVE PROTECTION FELT UNDERLAYMENT 7/16" ROOFING SHEATHING c/w 'H' CLIPS PRE-ENGINEERED TRUSSES @ 24" o.c. 2x4 TRUSS BRACING INSULATION STOPS MIN R50 BLOW IN INSULATION 6 mil POLY Y.B. 5/8" TYPE X GYPSUM BOARD SANDED AND PRIMED (1/2" CEILING BOARD INSTEAD OF 5/8" TYPE X OPTIONAL) (OPTIONAL-7/16" OSB SHEATHING WITH 1/2" STANDARD DRYWALL)

2X6 FASCIA BOARD ALUMINUM DRIP EDGE 6" ALUMINUM EAVES ALUMINUM VENTED SOFFITS

PREFINISHED ALUMINUM EAVES TROUGH & DOWN SPOUTS

UNOBSTRUCTED ATTIC YENT AREA SHALL BE NOT LESS THAN 1/300 OF THE CEILING AREA, NOT LESS THAN 25% OF REQUIRED OPENINGS SHALL BE AT THE BOTTOM OF THE SPACE AND NOT LESS THAN 25% OF THE REQUIRED OPENINGS SHALL BE AT THE TOP OF THE SPACE.

TYPICAL EXTERIOR WALL DETAIL

SIDING EXTERIOR WRAP 7/16" OSB SHEATHING 2x6 STUDS @ 16" o.c. DOUBLE TOP PLATE SINGLE BOTTOM PLATE R20 BATT INSULATION 6 mil POLLY Y.B. 1/2" DRYWALL TAPED & SANDED

TYPICAL INTERIOR 2X4 WALL DETAIL


1/2" DRYWALL TAPED & SANDED 2x4 STUDS @ 16" o.c. RI2 BATT INSULATION IN BATHROOM WALLS 1/2" DRYWALL TAPED & SANDED

TYPICAL FLOOR SYSTEM

FINISH FLOOR ON UNDERLAY AS REQUIRED 3/4" T&G OSB SUBFLOOR SCREWED & GLUED 9 1/2" ENGINEERED I JOISTS

TYPICAL FOUNDATION DETAILS

SEE FOUNDATION DRAWING

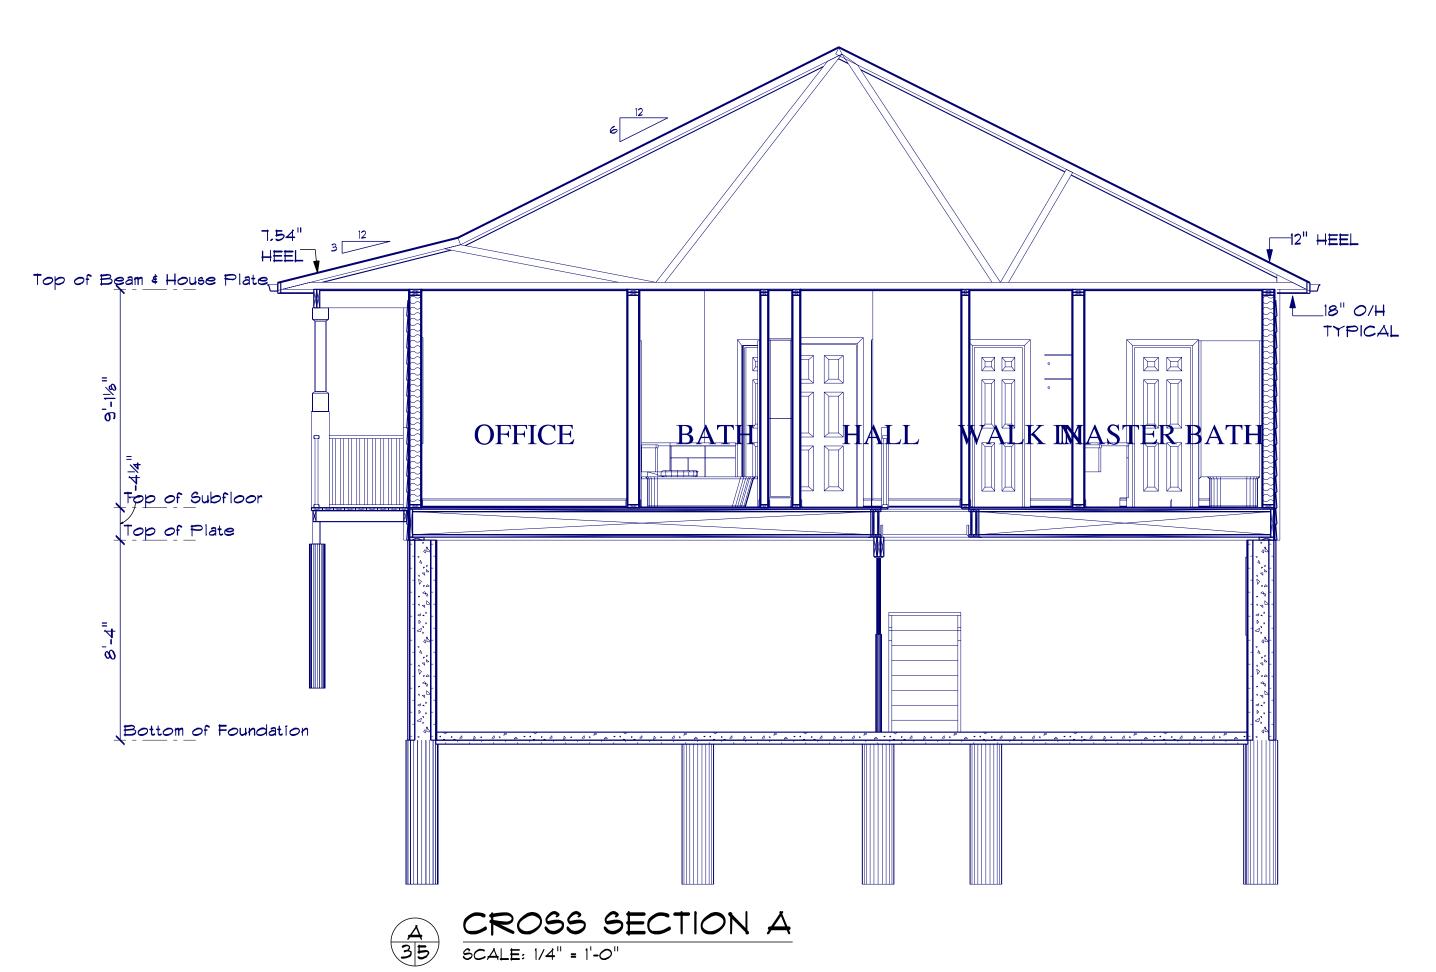



CROSS SECTION & TYPICALS


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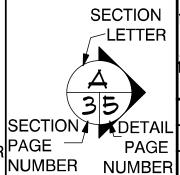


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3



PROJECT FOR: MR, & MRS, JOHN DOE -LETTER BOX 100 ANYTOWN MANITOBA RIR IRI

DRAWN BY: YERLIN PAGE #: SCALE: 1/4" = 1'-0" DATE: Friday, November 25, 2016

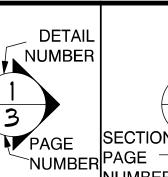
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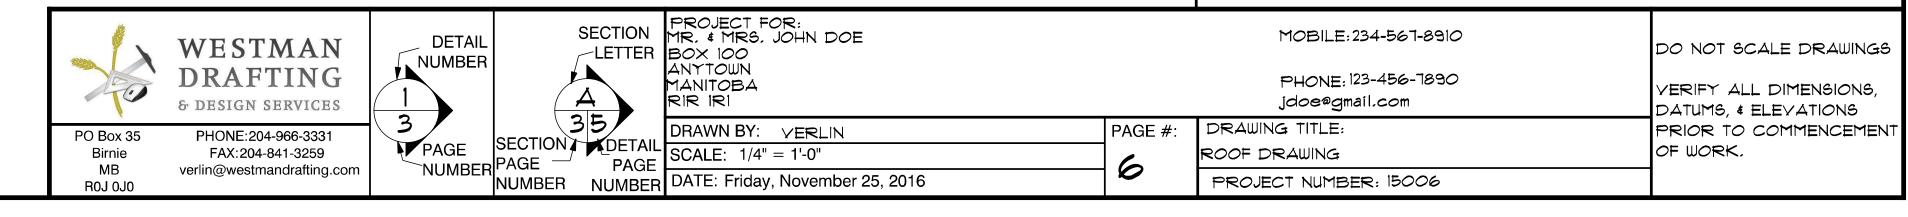
DATUMS, & ELEVATIONS PRIOR TO COMMENCEMENT OF WORK,





SCALE: 1/4" = 1'-0"

PROJECT DESCRIPTION:

1496 SQ, FT, BUNGALOW ON ICF BASEMENT

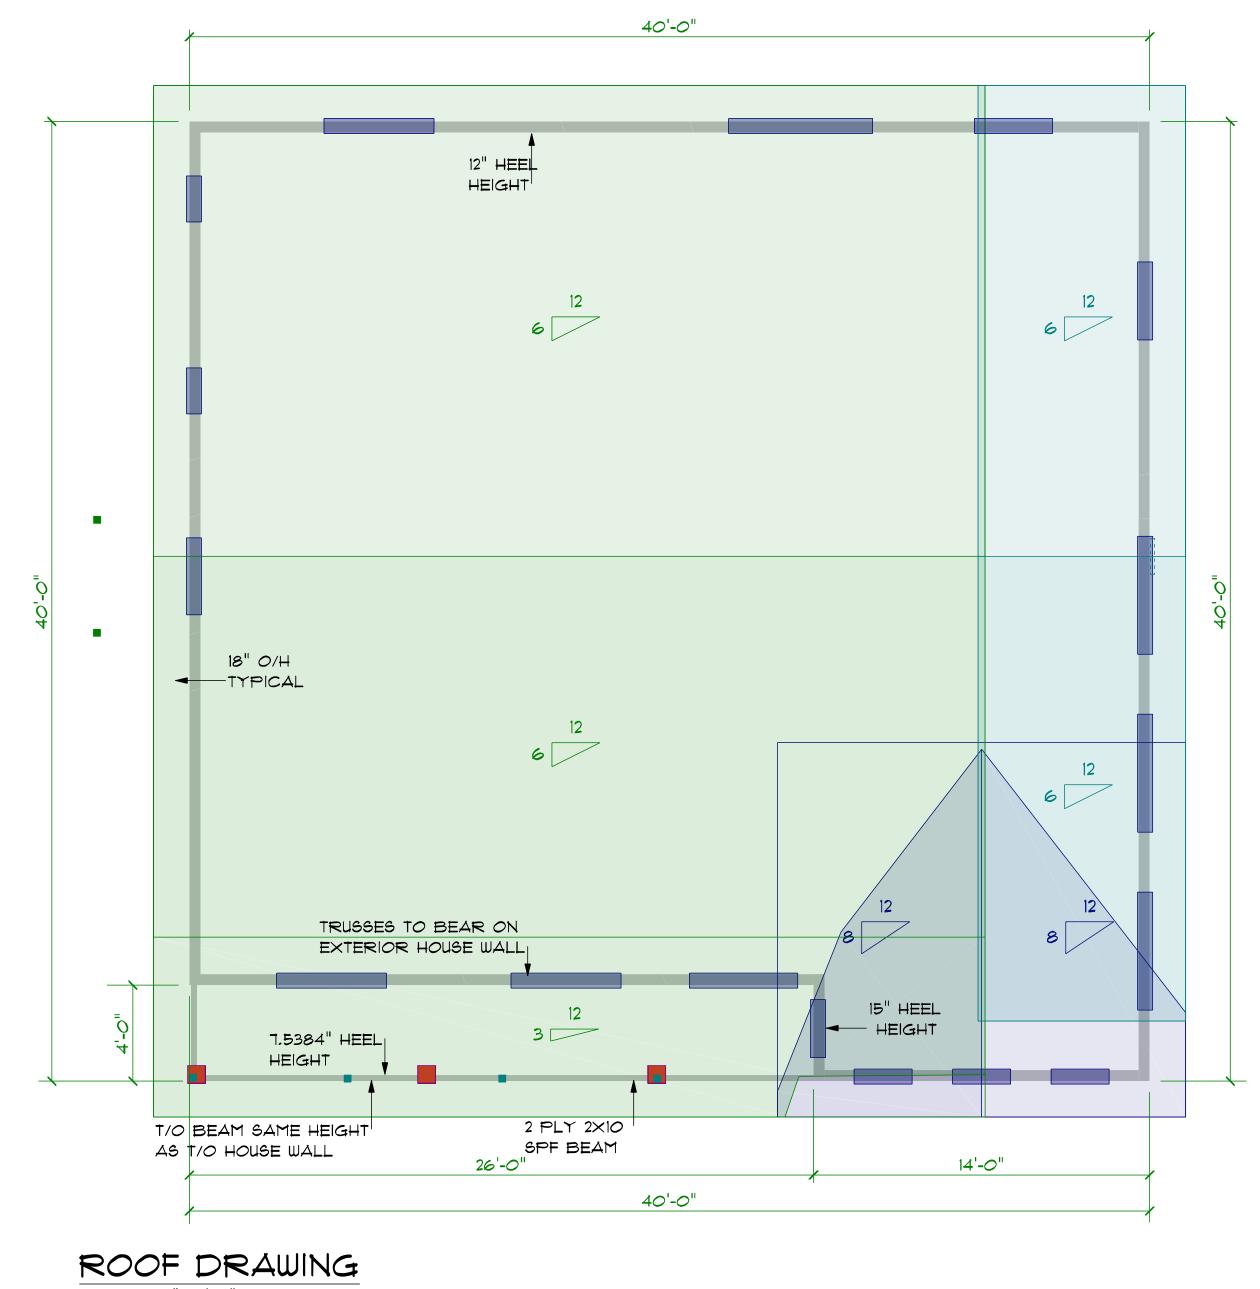

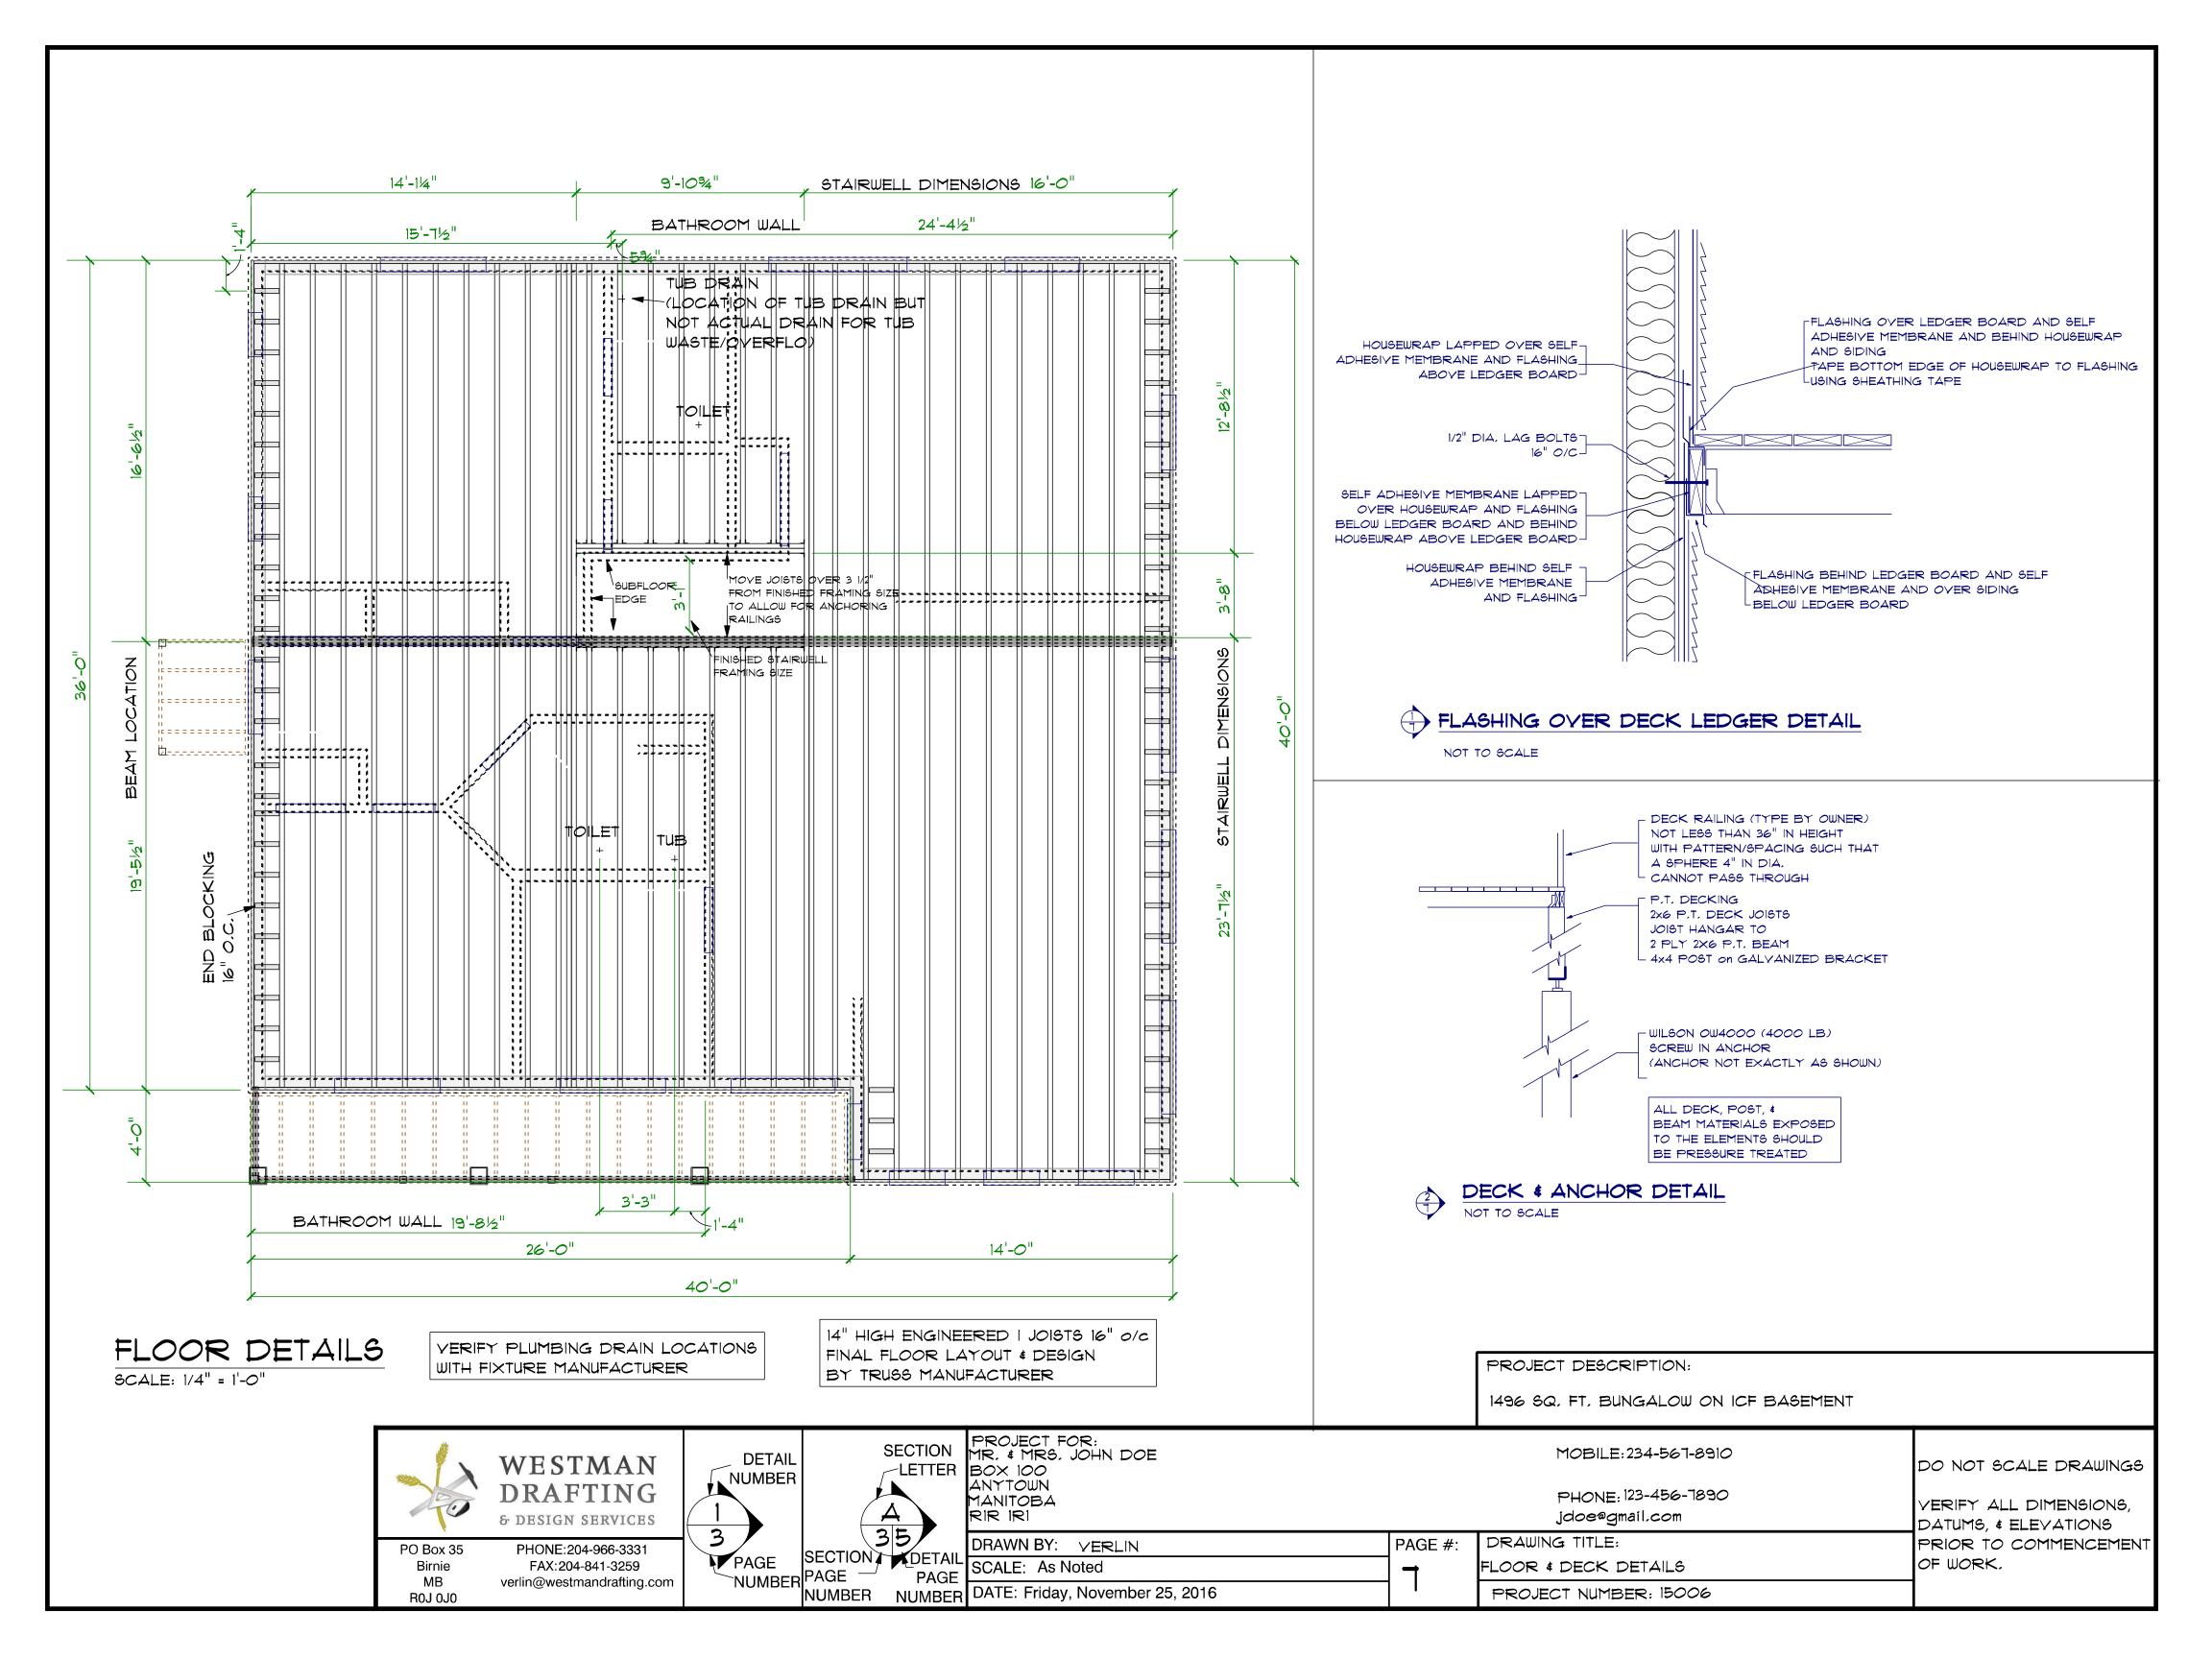

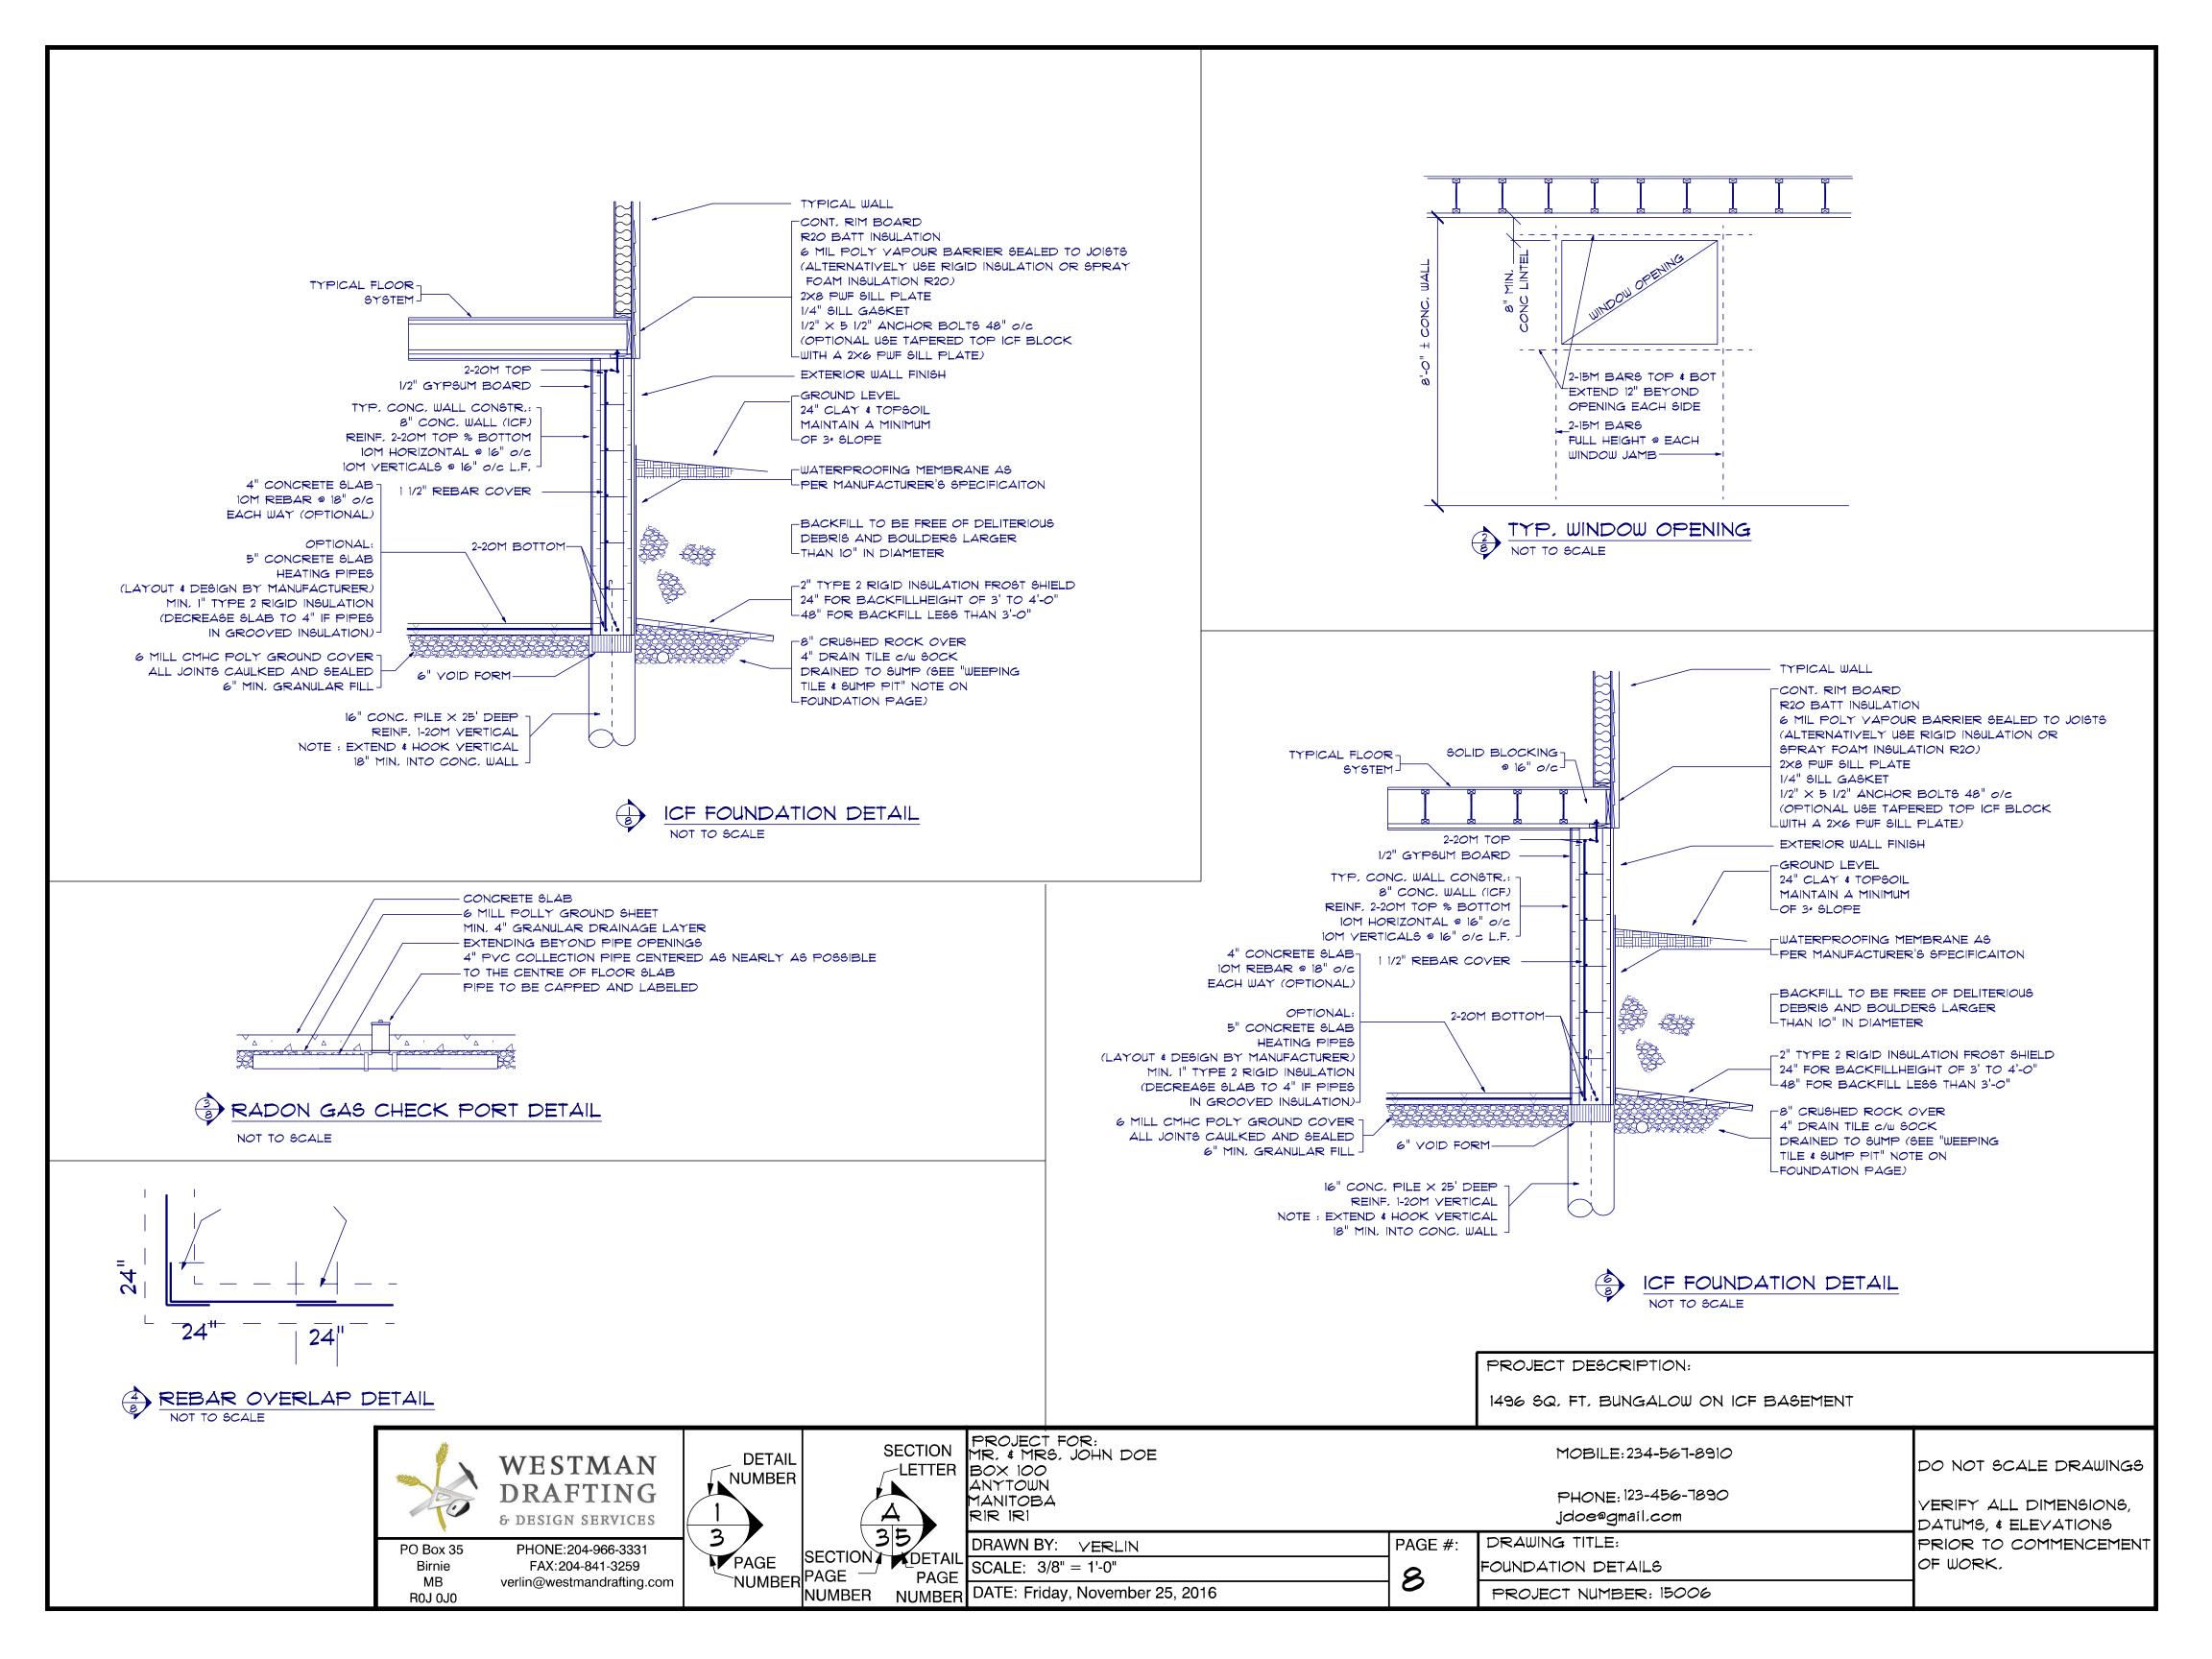

GENERAL NOTES

AS A MINIMUM ALL WORK MUST CONFORM TO THE LATEST EDITION OF THE NATIONAL BUILDING CODE, NATIONAL PLUMBING CODE, NATIONAL MECHANICAL CODE, NATIONAL FIRE CODE AND THE LATEST EDITION OF THE NATIONAL ELECTRICAL CODE AS WELL AS THEIR ADDENDA AND REFERENCED STANDARDS

IT IS THE CONTRACTOR(S) OR OWNER(S) RESPONSIBILITY TO INFORM THEMSELVES OF THE EXACT LOCATION OF AND ASSUME ALL LIABILITY FOR DAMAGE TO: ALL POLE LINES, CONDUITS, WATER MAINS, SEWERS & ALL UNDERGROUND AND ABOYE GROUND UTILITIES & STRUCTURES BEFORE COMMENCING WORK, SUCH DETAIL MAY OR MAY NOT BE SHOWN ON THIS DRAWING(S) AND THEIR LOCATION SHOWN MAY NOT BE EXACT.

"WESTMAN DRAFTING" IS NOT RESPONSIBLE FOR ANY MISINTERPRETATION OF THESE PLANS AND WILL NOT TAKE RESPONSIBILITY FOR CHANGE(S) MADE BY OWNER(S), CONTRACTOR(S) OR OTHER OFFICIAL(S) REGARDING THIS

ANY CHANGES MUST BE REPORTED (IN WRITING) TO "WESTMAN DRAFTING" PRIOR TO CONSTRUCTION IN ORDER TO RECEIVE REVISED DRAWING(S).

"WESTMAN DRAFTING RESERVES THE RIGHT TO REUSE THESE PLAN(S) IN PARTS OR IN WHOLE, THE OWNER(S) OR CONTRACTOR(S) SHALL NOT REUSE THESE PLAN(S) IN ANY SHAPE OR FORM OTHER THAN FOR THIS PROJECT.

FOUNDATION

EXCAVATE ALL TOPSOIL, ORGANIC MATERIAL, LOOSE OR UNSUITABLE FILL AND REMOVE FROM SITE.

THE EXPOSED SUB GRADE FOR SLABS ON GRADE SHALL BE PROOF ROLLED AND ANY SOFT SPOT REVEALED SHALL BE EXCAYATED, BACKFILLED WITH GRANULAR FILL AND COMPACTED, GRANULAR FILL AND COMPACTION METHOD SHALL BE APPROVED BY THE ENGINEER PRIOR TO COMMENCEMENT,

WHERE APPLICABLE, NON-PERFORATED DRAIN TILE TO BE USED TO CONNECT DRAIN TILE ON PERIMETER OF FOUNDATION TO SUMP PIT.

INSTALL A 6 MIL CMHC YAPOUR BARRIER UNDER CONCRETE SLABS, THE POLY SHALL BE SEALED AT THE EDGES OF THE FOUNDATION WALL, AT ALL JOINTS, AND AT ALL PENETRATIONS.

FOUNDATION PLATES/SILLS SHALL BE PRESSURE TREATED WOOD AND SHALL BE BOLTED TO THE FOUNDATION WITH NOT LESS THAN 1/2" DIAMETER BOLTS IMBEDDED AT LEAST 4" INTO CONCRETE AND SPACED NOT MORE THAN 4 FEET APART OR AS OTHERWISE NOTED, BOLTS TO BE LOCATED WITHIN 9 INCHES OF EACH END OF EACH SILL PIECE,

ALL CUTS AND HOLES IN PRESSURE TREATED SILL PLATE SHALL BE PROTECTED BY TWO APPLICATIONS OF COPPER NAPHTHENATE PRESERVATIVE APPLIED BY BRUSHING, SPRAYING, OR DIPPING.

FOUNDATION WALLS TO EXTEND AT LEAST 6 INCHES ABOVE FINISHED GRADE.

SUMP PIT DETAILS

SUMP PIT TO BE NOT LESS THAN 30" DEEP, NOT LESS THAN 2.7 SQ.FT. IN AREA AND PROVIDED WITH A AIR-TIGHT CHILD RESISTANT COVER.

WHERE GRAVITY DISCHARGE IS NOT PRACTICAL, AN AUTOMATIC SUMP PUMP SHALL BE PROVIDED TO DISCHARGE THE WATER INTO A DRAINAGE DITCH OR DRY WELL.

DRAINAGE

FINISH GRADE TO SLOPE AWAY FROM STRUCTURES SO THAT WATER WILL NOT ACCUMULATE AT OR NEAR

DOWNSPOUTS WITH EXTENSIONS SHALL BE PROVIDED TO CARRY RAINWATER AWAY FROM BUILDING IN SUCH A MANNER THAT WILL PREVENT SOIL EROSION.

ROOF COVERING

ROOFING MATERIALS SHALL BEAR THE LABEL OF AN APPROVED AGENCY AND SHALL BE FASTENED ACCORDING TO THE MANUFACTURER'S INSTRUCTIONS.

EXTERIOR DECK MEMBRANES ARE TO BE INSTALLED AS PER MANUFACTURER'S SPECIFICATIONS

FLASHING REQUIRED IN ROOF VALLEYS, AND WHERE THE ROOF INTERSECTS THE WALLS.

THE CHIMNEY REQUIRES A SADDLE WHERE THE UPPER SIDE OF THE CHIMNEY MEETS THE ROOF AS PER ART, 9.26.4.8 OF THE MBC.

ATTIC YENTILATION

ATTIC SHALL BE PROVIDED WITH A MINIMUM NET FREE VENTILATING AREA NOT LESS THAN 1/300 OF THE INSULATED CEILING AREA.

REQUIRED YENTS MAY BE ANY COMBINATION OF ROOF TYPE, EAVE TYPE, OR GABLE TYPE AND SHALL BE DISTRIBUTED UNIFORMLY ON OPPOSITE SIDES OF THE BUILDING WITH NOT LESS THAN 25% OF THE REQUIRED OPENINGS LOCATED AT THE TOP OF THE SPACE AND NOT LESS THAN 25% OF THE REQUIRED OPENINGS LOCATED AT THE BOTTOM OF THE SPACE.

ATTIC ACCESS

ATTIC ACCESS SHALL BE PROVIDED BY A HATCHWAY AT LEAST 20" imes 28"

YAPOUR BARRIER

ALL VAPOUR BARRIER SHALL CONFORM TO CAN/CGSB-51,34-M ALL JOINTS AND PENETRATIONS (WINDOWS, ELECTRICAL WIRING, BOXES, PIPING, ETC.) IN VAPOUR BARRIER SHALL BE SEALED WITH ACOUSTICAL SEALANT

EMERGENCY ESCAPE WINDOWS

EYERY SLEEPING ROOM TO BE PROVIDED WITH AT LEAST ONE OPERABLE EXTERIOR WINDOW OR DOOR APPROVED FOR EMERGENCY ESCAPE OR RESCUE. THE UNITS SHALL BE OPERABLE FROM THE INSIDE TO PROVIDE A FULL CLEAR OPENING WITHOUT THE USE OF SEPARATE TOOLS.

ALL ESCAPE/RESCUE WINDOWS FROM SLEEPING ROOMS SHALL HAVE A MINIMUM NET OPENING AREA OF 4.0 SQ. FT. THE MINIMUM NET CLEAR OPENABLE HEIGHT DIMENSION SHALL BE 16 INCHES. THE MINIMUM NET CLEAR OPENABLE WIDTH DIMENSION SHALL BE 16 INCHES.

WHERE A WINDOW OPENS INTO A WINDOW-WELL, A CLEARANCE OF NOT LESS THAN 30" SHALL BE PROVIDED IN FRONT OF THE WINDOW. WHERE THE SASH OF A WINDOW OPENS TOWARDS THE WINDOW-WELL, THE OPERATION OF THE SASH SHALL NOT REDUCE THE CLEARANCE IN A MANNER THAT WOULD RESTRICT ESCAPE IN AN EMERGENCY.

FIRE BLOCKING AND DRAFT STOPS

FIRE BLOCKING AND DRAFT STOPPING SHALL BE INSTALLED TO CUT OFF ALL CONCEALED DRAFT OPENINGS (BOTH VERTICAL AND HORIZONTAL) AND SHALL FORM AN EFFECTIVE BARRIER BETWEEN FLOORS, BETWEEN TOP STORY AND A ROOF OR ATTIC

PROVIDE AT ALL INTERCONNECTIONS BETWEEN CONCEALED VERTICAL AND HORIZONTAL SPACES SUCH AS OCCUR AT SOFFITS, DROP CEILINGS AND COYE CEILINGS

PROVIDE AT CONCEALED SPACES BETWEEN STAIR STRINGERS AT THE TOP AND BOTTOM OF THE RUN AND BETWEEN STUDS ALONG AND IN LINE WITH THE RUN OF

PROVIDE AT OPENINGS AROUND VENTS, PIPES, DUCTS AND SIMILAR OPENINGS WHICH AFFORD A PASSAGE FOR FIRE AT CEILING AND FLOOR LEVELS, WITH NONCOMBUSTIBLE MATERIALS.

FIRE WARNING SYSTEMS

PROVIDE A SMOKE/CO ALARM IN ALL STORAGE GARAGES, AT LEAST ONE SMOKE/CO ALARM ON EACH FLOOR INCLUDING BASEMENTS AND CRAWLSPACES, IN THE MECHANICAL ROOM, IN EACH BEDROOM, AND BETWEEN THE BEDROOMS AND THE REMAINDER OF THE FLOOR (IF THE BEDROOMS ARE SERVED BY A HALLWAY THE ALARM IS TO BE INSTALLED IN THE HALLWAY).

ALL SMOKE/CO ALARMS ARE TO BE HARDWIRED AND INTERCONNECTED SO THAT THE ACTIVATION OF ONE ALARM WILL CAUSE THEM ALL TO SOUND.

A FIXED TEMPERATURE HEAT SENSOR IS TO BE INSTALLED IN EACH ATTACHED STORAGE GARAGE AND WIRED SO THAT THE ACTIVATION OF THE SENSOR WILL CAUSE ALL REQUIRED SMOKE/CO ALARMS WITHIN THE DWELLING UNIT

ELECTRICAL AND MECHANICAL

ELECTRICAL AND MECHANICAL DRAWINGS BY APPLICABLE ENGINEER/CONTRACTOR

INTERIOR RAILINGS AND GUARDS

ALL STAIRS REQUIRE A HANDRAIL THE GUARD RAILS FOR STAIRS ARE REQUIRED TO BE 32" IN HEIGHT ABOVE A LINE DRAWN THROUGH THE STAIR NOSINGS AND 36" IN HEIGHT ABOVE LANDINGS, OPENINGS THROUGH THE GUARDS MUST BE A SIZE TO PREVENT THE PASSAGE OF A SPHERICAL OBJECT 4" IN DIAMETER, GUARD RAILS MUST BE DESIGNED TO PREVENT CLIMBING.

PAGE #

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EXACT RISE AND RUN TO BE DETERMINED ON SITE. STAIRS SHALL HAVE A MAXIMUM RISE OF 7 7/8" A MINIMUM RUN OF 8 1/4", AND A MINIMUM TREAD DEPTH OF 9 1/4", STAIRS REQUIRE A MINIMUM HEADROOM OF 6'-4" MEASURED VERTICALLY FROM A LINE DRAWN THROUGH THE OUTER EDGES OF THE STAIR NOSINGS.


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SECTION -LETTER 35 SECTION DETAIL **PAGE** NUMBER NUMBER

PROJECT FOR: MR. & MRS. JOHN DOE BOX 100 ANYTOWN MANITOBA

RIR IRI

DRAWN BY: YERLIN SCALE: 3/16" = 1'-0" DATE: Friday, November 25, 2016

PHONE: 123-456-7890 jdoe@gmail.com DRAWING TITLE:

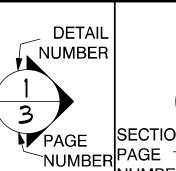MOBILE: 234-567-8910

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GENERAL NOTES PROJECT NUMBER: 15006